NOTICE OF AN APPLICATION FOR PLANNING PERMIT

| The land affected by the application is located at: | Lot 83 LP8039 16 Haylock Avenue, Cockatoo |
|---|---|
| The application is for a permit to: | Development of the land for a dwelling vegetation removal |
| The applicant for the permit is: | Swenrick Constructions (Vic) Pty Ltd |
| The application reference number is: | T170028 |
| You may look at the application and any documents that support the application at the office of the | Cardinia Shire Council 20 Siding Avenue Officer 3809 |
| Responsible Authority: | This can be done during office hours and is free of charge. Documents can also be viewed on Council's website www.cardinia.vic.gov.au. |

Any person who may be affected by the granting of the permit may object or make other submissions to the responsible authority.

| An (| objection | must |
|------|-----------|------|
|------|-----------|------|

- be sent to the Responsible Authority in writing, at Cardinia Shire Council, PO Box 7, Pakenham, Vic, 3810 or email at mail@cardinia.vic.gov.au
- * include the name and address of the objector/ submitter
- * include the application number and site address
- * include the reasons for the objection, and
- * state how the objector would be affected.

| The Responsible Authority will not decide on the application before: | 4 April 2017 |
|--|--------------|
|--|--------------|

If you object, the Responsible Authority will advise you of its decision.

Please be aware that copies of objections/submissions received may be made available to any person for the purpose of consideration as part of the planning process.

For additional information or advice contact Cardinia Shire Council, Planning Department on 1300 787 624 or mail@cardinia.vic.gov.au

Your objection/ submission and personal information is collected by Cardinia Shire Council for the purposes of the planning process as set out in the *Planning and Environment Act 1987*. If you do not provide your name and address, Council will not be able to consider your objection/ submission. Your objection/ submission will be available free of charge at the Council office for any person to inspect and copies may be made available on request to any person for the relevant period set out in the *P&E Act*. You must not submit any personal information or copyright material of third parties without their informed consent. By submitting the material, you agree that the use of the material as detailed above does not breach any third party's right to privacy and copyright.





AREAS m^2 59 173.02m 125.39m GROUND FLOOR: 18.6259 VERANDAH: 13.5059 TOTAL: 298.404m² 32.125a

This copied document is made available for the purpose of the planning process as set out in the Planning and Environment Act 1987. The information must not be used for any other purpose. By taking a copy of this document you acknowledge and agree that you will only use the document for the purpose specified above and that any dissemination, distribution or copying of this document is strictly prohibited.

SMOKE ALARMS

SMOKE DETECTORS SHALL BE INSTALLED ON ENTRY LEVEL IN ACCORDANCE WITH AS 3786-1993 AND B.C.A PART 3.72. NEW SMOKE ALARMS MUST BE CONNECTED DIRECTLY TO CONSUMER MAINS POWERS WHERE CONSUMER MAINS POWER IS SUPPLIED TO THE BUILDING. THE B.C.A REQUIRES THE INTERCONNECTION OF SMOKE ALARMS WHERE MORE THAN ONE ALARM IS REQUIRED TO BE INSTALLED.

TOILET DOORS

TOILET DOORS ARE TO BE FITTED WITH REMOVABLE HINGES, OR THEY ARE TO SWING OUT, OR BE SLIDING WHERE THEY ARE WITHIN 1200MM OF THE PAN. TOILET DOORS ARE TO BE FITTED WITH REMOVABLE HINGES, OR THEY ARE TO SWING OUT, OR BE SLIDING WHERE THEY ARE WITHIN 1200MM OF THE PAN.

PROPOSED DWELLING

16 HAYLOCK AVENUE, COCKATOO

JOB ADDRESS:

AM - 1

A++

PROGRAM:

K PRITCHARD & K GARDINER

FLOOR PLAN


SHEET NAME:

THERMAL INSULATION

- · CEILINGS R 4.0
- FLOORS R 1.5
- EXTERNAL WALLS R 2.0

LEGEND

- S -SMOKE DETECTOR (HARD WIRED)
- -EXHAUST FANS
- ELEC. SWITCHBOARD
- (G) LP GAS BOTTLE
- DOWN PIPE
- (HW) ELECTRIC HOT WATER SERVICE
- CN SPLIT SYSTEM CONDENSER
- ST SPLIT SYSTEM HEAD

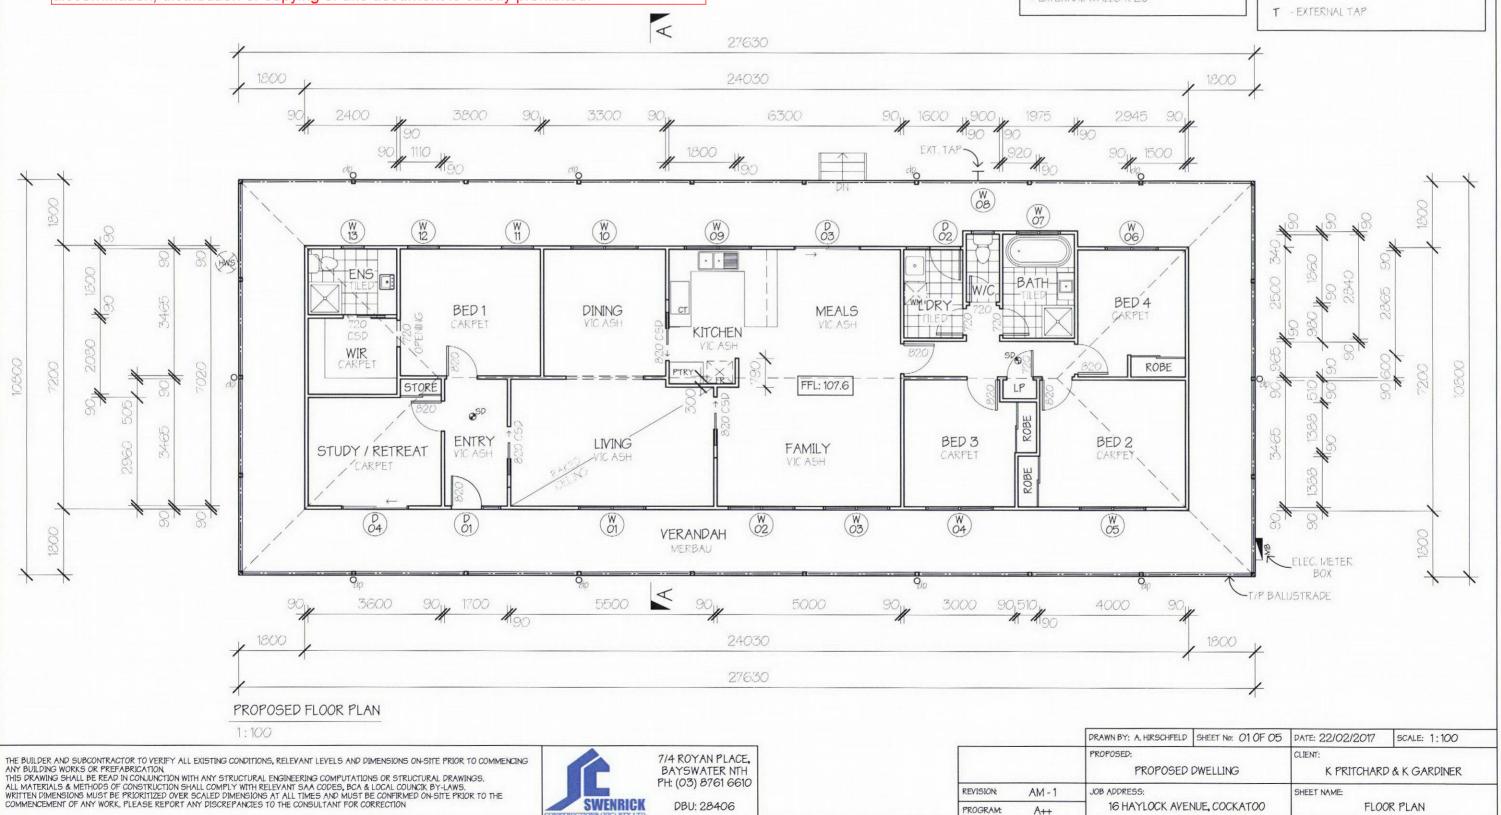

BAYSWATER NTH

PH: (03) 8761 6610

DBU: 28406

SCHEDULE OF FINISHES

CLADDING

HARDIES 230mm PRIMELINE SUMMIT WEATHERBOARDS

SUB-FLOOR ROOF

PAINTED - "DULUX SILKWORT"

NORTH ELEVATION

1:100

CORRUGATED COLORBOND IN - "IRONSTONE" CORRUGATED COLORBOND IN "IRONSTONE" ALUMINIUM FRAMES POWDER COATED "WHITE" WINDOW FRAMES FASCIAS

FASCIAS IN DULUX "WHISPER WHITE" COLORBOND GUTTERS IN "IRON STONE" GUTTERS VERANDAH POSTS - PAINTED DULUX "WHISPER WHITE" BALUSTRADES - PAINTED DULUX "WHISPER WHITE" DECKING - MERBAU - STAINED (NO TINT)

BAL 29 NOTES

COLORBOND

SUB FLOOR

CLADDING

- ROOF TO BE FULLY SARKED WITH GAPS GREATER THAN 3MM TO BE SEALED WITH STEEL OR ALUMINIUM MESH WITH A MAX APERTURE OF 2MM. WINDOWS SHALL BE ALUMINIUM AWNING WITH 5mm TOUGHENED GLASS
- OPENABLE SAHES TO HAVE FLYSCREENS WITH ALUMINIUM MESH - EXTERNAL DOORS TO BE KDHW FRAME AND SOLID CORE DOOR WITH ALUMINIUM MESH FLYSCREEN DOORS
- SLIDING DOORS TO BE ALUMINIUM FRAME WITH 6mm TOUGHENED GLASS AND ALUMINIUM MESH FLYSCREEN DOORS
- VERANDAH POSTS TO BE 90 x 90 MERBAU VERANDAH BEAM TO BE F17 WITH COLORBOND FACE
- RAFTERS & ROOF BATTENS F17

TIMBER SPECIFICATION

| LINTELS: | JAMB STUDS: | MAX OPENING: |
|------------------|----------------|--------------|
| 90 x 45 MGP 10 | 90 x 45 MGP 10 | 1000 |
| 140 x 45 F7 | 90 x 45 MGP 10 | 1800 |
| 140 x 42 LVL F17 | 90 x 45 MGP 10 | 2400 |
| 190 x 45 F17 | 90 x 45 MGP 10 | 3000 |

SINGLE STOREY LOAD BEARING WALLS:

1/90 x 45 & 1/90 x 35 MGP 10 TOP PLATES TO EXTERIOR WALLS

90 x 45 MGP 12 BOTTOM PLATES


90 x 35 MGP 10 COMMON STUDS AT 450 CTS TO EXTERIOR

WALLS & GOO CTS TO INTERIOR WALLS

35 x 90 MGP 10 NOGGINGS - BRACING IN ACCORDANCE WITH AS 1684

NON LOAD BEARING WALLS:

- 45 × 90 MGP 10 TOP & BOTTOM PLATES (INTERIOR WALLS) - 90 × 35 MGP 10 COMMON STUDS AT 600 CTS (INTERIOR WALLS)

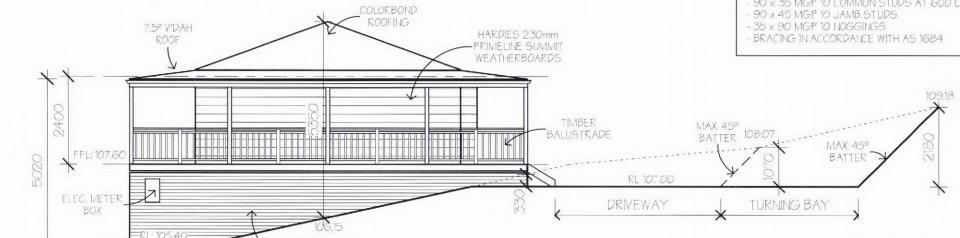

This copied document is made available for the purpose of the planning process as set out in the Planning and Environment Act 1987. The information must not be used for any other purpose. By taking a copy of this document you acknowledge and agree that you will only use the document for the purpose specified above and that any dissemination, distribution or copying of this document is strictly prohibited

WALL FRAMING

TIMBER WALL FRAMING IS TO COMPLY WITH AS 1684 - 2010 "RESIDENTIAL TIMBER FRAMED CONSTRUCTION" AND WITH SUPPLEMENTARY TABLES. PROVIDE DOUBLE STUD, STUMP & PAD UNDER ALL LOAD POINTS. ALL STRUCTURE STEEL IS TO COMPLY WITH AS 4100 STEEL STRUCTURES

WATERPROOFING

PROVIDE IMPERVIOUS FINISHES TO ALL WET AREAS I.E. 1800 HIGH ABOVE SHOWERS, 150MM ABOVE THE BATH & BASINS.-REFER BCA 3.8.1 PROVIDE WATERPROOF MEMBRANE TO ENTIRE BATHROOM FLOORS AND TANKING OF SHOWERS AS PER A.S. 3740-2010

STEPS & HANDRAILS

LANDINGS & STEPS AS PER 3.9.1 - HANDRAILS AS PER 3.9.2

STEPS - GOINGS MIN. 240mm TO MAX. 355mm

RISERS MIN. 115mm TO MAX. 190mm

- 2r + 1g IVIIN 550mm TO MAX. 700mm - MAX. 124mm GAP TO OPEN TREADS

NON SLIP FINISH TO ALL TREADS AND LANDINGS

ENSURE MIN. 2m HEAD HEIGHT ABOVE NOSING IN STAIRS.


PROVIDE BALUSTRADE /BARRIER WHERE CHANGE IN LEVEL EXCEEDS 1000mm ABOVE SURFACE BENEATH FLOORS, LANDINGS, RAMPS AND/OR TREADS. BALUSTRADE/BARRIER (other than tensioned wire balustrades) to

1000mm ABOVE FINISHED SURFACE LEVEL 865mm ABOVE STAIR NOSING OR RAMP SURFACE)

VERTICAL, WITH MAX. 124mm GAPS

ANY HORIZONTAL ELEMENT WITHIN THE BALUSTRADE/BARRIER BETWEEN 150mm AND 760mm ABOVE FLOOR MUST NOT FACILITATE CLIMBING WHERE CHANGES LEVEL EXCEEDS 4000mm ABOVE THE SURFACE BENEATH FLOORS, LANDINGS. RAMPS AND/OR TREADS.

> SITE CLASSIFICATION: "P" SOIL CLASSIFICATION: "I/I" ALL STUMP/PAD FOOTINGS TO BE FOUNDED AT MIN. DEPTH OF 100mm INTO THE NATURAL CLAY OR 1800mm WITH AN ASSUMED BEARING PRESSURE OF 150kPa. REFER GE ENGINEERING SOIL REPORT No. 3110-00179-1

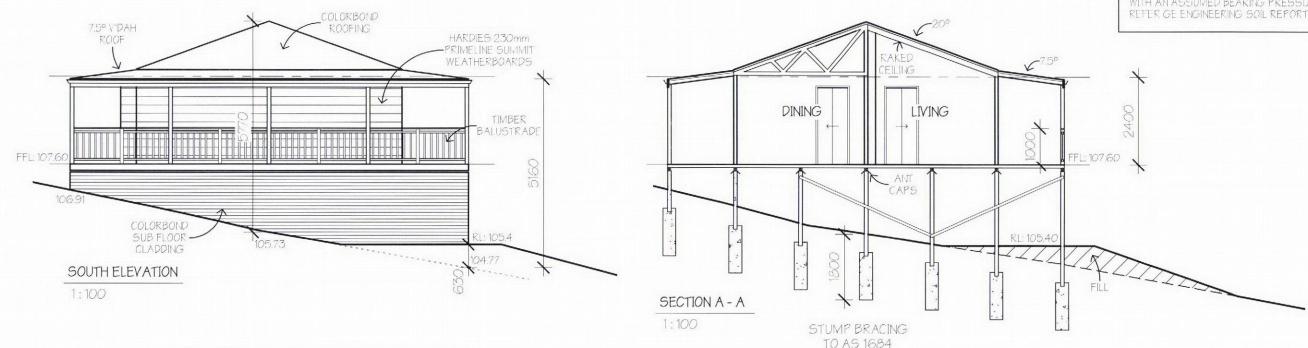

THE BUILDER AND SUBCONTRACTOR TO YERIFY ALL EXISTING CONDITIONS, RELEVANT LEVELS AND DIMENSIONS ON-SITE PRIOR TO COMMENCING ANY BUILDING WORKS OR PREFABRICATION

THIS DRAWING SHALL BE READ IN CONJUNCTION WITH ANY STRUCTURAL ENGINEERING COMPUTATIONS OR STRUCTURAL DRAWINGS, ALL MATERIALS & METHODS OF CONSTRUCTION SHALL COMPLY WITH RELEVANT SAA CODES, BCA & LOCAL COUNCIR, BY-LAWS, WRITTEN DIMENSIONS MUST BE PRIORITIZED OVER SCALED DIMENSIONS AT ALL TIMES AND MUST BE CONFIRMED ON-SITE PRIOR TO THE COMMENCEMENT OF ANY WORK, PLEASE REPORT ANY DISCREPANCIES TO THE CONSULTANT FOR CORRECTION



7/4 ROYAN PLACE, BAYSWATER NTH PH: (03) 8761 6610

DBU: 28406

| | | DRAWN BY: A. HIRSCHFELD | SHEET No: 02 0F 05 | PATE: 22/02/2017 | SCALE: 1:100 |
|-----------|--------|-------------------------|--------------------|----------------------------------|--------------|
| | | PROPOSED DWELLING | | CLIENT: K PRITCHARD & K GARDINER | |
| REVISION: | AM - 1 | JOB ADDRESS: | | SHEET NAME; | |
| PROGRAM: | A++ | 16 HAYLOCK AVE | NUE, COCKATOO | ELEVATI | ON/SECTION |

| | WINDOW SCHEDULE | | | |
|-----|-----------------|-------------|--|--|
| No. | ROOM | SIZE | REMARKS | |
| 01 | LIVING | 1543 x 1810 | ALUM. D/GLAZED AWNING 5mm TOUGHENED 5/8/5 | |
| 02 | FAMILY | 1543 x 1810 | ALUM. D/GLAZED AWNING 5mm TOUGHENED 5/8/5 | |
| 03 | FAMILY | 1543 x 1810 | ALUM. D/GLAZED AWNING 5mm TOUGHENED 5/8/5 | |
| 04 | BED 3 | 1543 x 1810 | ALUM. D/GLAZED AWNING 5mm TOUGHENED 5/8/5 | |
| 05 | BED 2 | 1543 x 1810 | ALUM. D/GLAZED AWNING 5mm TOUGHENED 5/8/5 | |
| 06 | BED 4 | 1543 x 1450 | ALUM. D/GLAZED AWNING 5mm TOUGHENED 5/8/5 | |
| 07 | BATH | 1200 x 1210 | ALUM. S/GLAZED AWNING OBSCURED 5mm TOUGHENED | |
| 08 | W/C | 1027 x 610 | ALUM. S/GLAZED AWNING OBSCURED 5mm TOUGHENED | |
| 09 | KITCHEN | 1027 x 1810 | ALUM. D/GLAZED AWNING 5mm TOUGHENED 5/8/5 | |
| 10 | DINING | 1543 x 1810 | ALUM. D/GLAZED AWNING 5mm TOUGHENED 5/8/5 | |
| 11 | BED 1 | 1543 x 850 | ALUM. D/GLAZED AWNING 5mm TOUGHENED 5/8/5 | |
| 12 | BED 1 | 1543 x 850 | ALUM. D/GLAZED AWNING 5mm TOUGHENED 5/8/5 | |
| 13 | ENSUITE | 1027 x 610 | ALUM, S/GLAZED AWNING OBSCURED 5mm TOUGHENED | |

| | | EXTE | EXTERNAL DOOR SCHEDULE | | |
|-----|---------------|------------------------|--|--|--|
| No. | ROOM | SIZE | REMARKS | | |
| 01 | ENTRY | 2117 x 1330 (820 Door) | ALUM. FRAME 35mm SOLD CORE DOOR 5mm TOUGHENED GLASS | | |
| 02 | LAUNDRY | 2105 x 1470 x 1027 | ALUM. FRAME 35mm SOLID CORE DOOR ALUM. AWNING | | |
| 03 | MEALS | 2110 x 1810 | ALUM. SLIDING DOOR UNIT DIGLAZED 6mm TOUGHENED GLASS 6/6/6 | | |
| 04 | STUDY/RETREAT | 2110 x 1810 | ALUM. SLIPING DOOR UNIT DIGLAZED 6mm TOUGHENED GLASS 6/6/6 | | |

This copied document is made available for the purpose of the planning process as set out in the Planning and Environment Act 1987. The information must not be used for any other purpose. By taking a copy of this document you acknowledge and agree that you will only use the document for the purpose specified above and that any dissemination, distribution or copying of this document is strictly prohibited.

WINDOWS

ALL WINDOWS SHALL CONFORM TO AS 2047 - 2014 AND ALL GLAZING TO AS 1288 -2006 & BCA PART 3.6


GLAZING WITHIN 2000MM OF THE FFL IN BATHROOMS OR ENSUITES IS TO BE GRADE A


ALL SIZES SHOWN ARE NOMINAL AND SHOULD BE COMPARED TO MANUFACTURES STANDARD SCHEDULE BEFORE CONSTRUCTION COMMENCES AND BE CHECKED ON SITE PRIOR TO MANUFACTURING.

FIT ALUMINIUM MESH FLYSCREENS - 14 OFF

DOORS

DOORS WITH ALUMINIUM MESH TO DOORS - 4 OFF

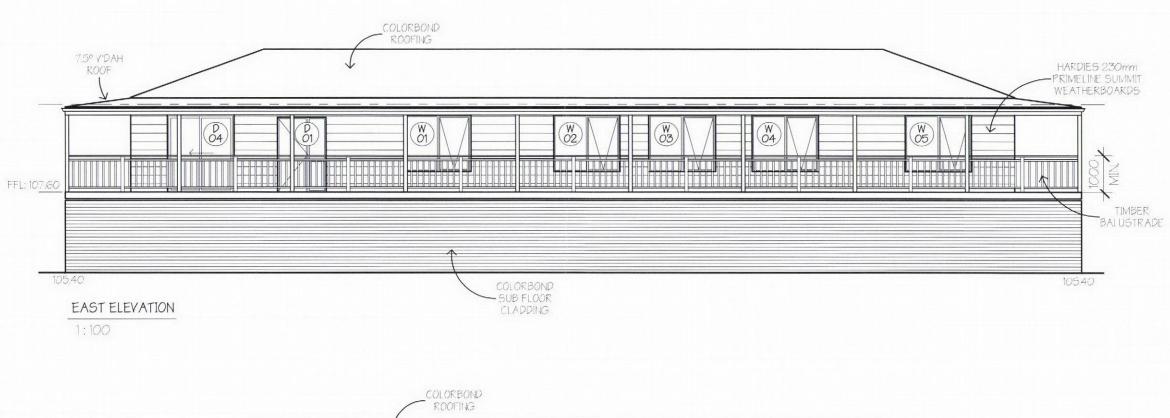

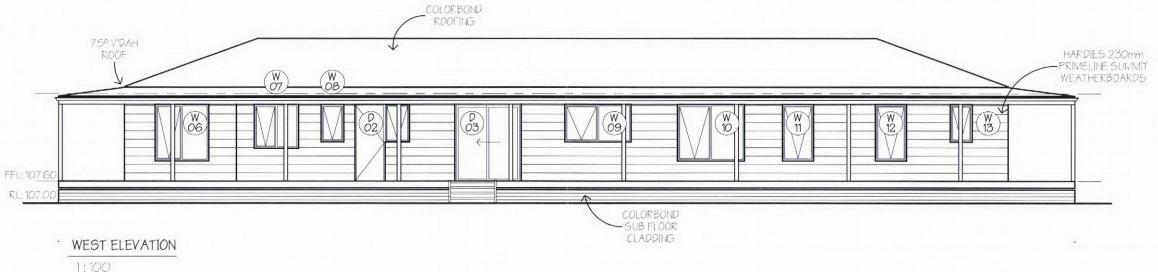

THE BUILDER AND SUBCONTRACTOR TO VERIFY ALL EXISTING CONDITIONS, RELEVANT LEVELS AND DIMENSIONS ON-SITE PRIOR TO COMMENCING ANY BUILDING WORKS OR PREFABRICATION
THIS DRAWING SHALL BE READ IN CONJUNCTION WITH ANY STRUCTURAL ENGINEERING COMPUTATIONS OR STRUCTURAL PRAWINGS.

ALL MATERIALS & METHODS OF CONSTRUCTION SHALL COMPLY WITH RELEVANT SAA CODES, BCA & LOCAL COUNCIK BY-LAWS.
WRITTEN DIMENSIONS MUST BE PRIORITIZED OVER SCALED DIMENSIONS AT ALL TIMES AND MUST BE CONFIRMED ON-SITE PRIOR TO THE
COMMENCEMENT OF ANY WORK, PLEASE REPORT ANY DISCREPANCIES TO THE CONSULTANT FOR CORRECTION



7/4 ROYAN PLACE, BAYSWATER NTH PH: (03) 8761 6610

DBU: 28406

| | | DRAWN BY: A. HIRSCHFELD | SHEET No: 03 OF 05 | DATE: 22/02/2017 | SCALE: 1:100 | |
|-----------|--------|---|--------------------|------------------|--------------------------|--|
| | | PROPOSED: | | CLIENT: | | |
| | | PROPOSED | PROPOSED DWELLING | | K PRITCHARD & K GARDINER | |
| REVISION: | AM - 1 | JOB ADDRESS: 16 HAYLOCK AVENUE, COCKATOO | | SHEET NAME: | | |
| PROGRAM: | A++ | | | ELEVATIONS | | |

